




DEVELOPMENT APPLICATION PROPOSED LANDSCAPE PLANS TOWNHOUSE DEVELOPMENT 12 - 16 FRANCIS STREET, MINTO.


DRAWING LIST

SHEET NO.	SHEET TITLE	DATE
L/00	COVER SHEET	07/03/19
L/01	LANDSCAPE PLAN	07/03/19
L/02	LIGHTING PLAN	27/09/19

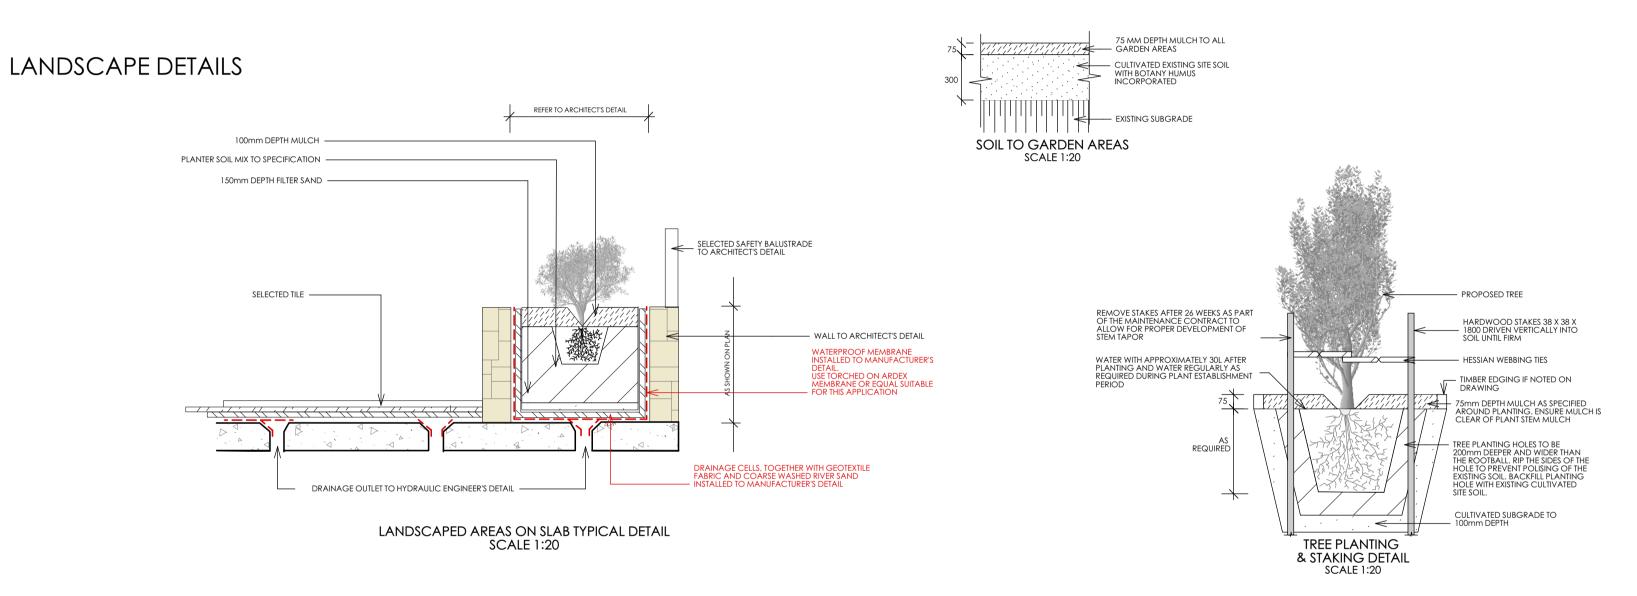

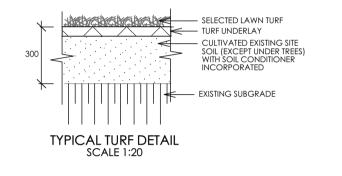

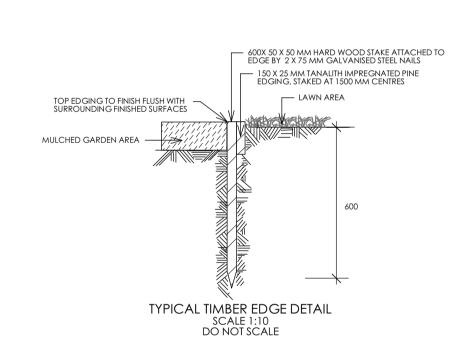

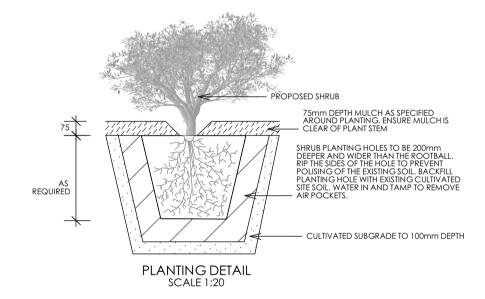

OUTLINE LANDSCAPE SPECIFICATION

Preparation by Builder: Builder: Builder shall remove all existing concrete pathways, fences, footings, walls etc. and make good all existing kerbs, gutters etc. as necessary and to approval of Council. Builder shall ensure that a minimum 450mm of topsoil in garden areas and a minimum 150mm of topsoil in lawn areas exists. Should required depths not exist Builder shall contact Landscape Architect and ask for instructions prior to completion of excavation works. xcavate as necessary, then fill with approved site topsoil to allow for minimum 500mm soil depth in garden areas and 150mm soil depth in lawn areas and to gain required shapes & levels. Ensure all garden and lawn areas drain satisfactorily. All levels & surface drainage shall be determined by others & approved on site topsoil depth in lawn areas and 150mm soil depth in lawn areas and 150mm soil depth in lawn areas and to gain required shapes & levels. Ensure all garden areas and 150mm soil depth in lawn areas and 150mm soil depth in garden areas and 150mm soil depth in lawn areas and 150mm soil depth in topsoil and the quantities of both site topsoil and imported topsoil allowed for in Tender. Initial Preparation: Verify all dimensions & levels on site prior to commencement. Do not scale from drawings, Locate all underground & above ground services & ensure no damage occurs to them throughout contract. Spray approved weeds from site, Levels indicated on Plan are nominal only and are derived from Architectural Plans & Drawings by others. Final structural integrity of all items shall be the sole responsibility of Landscape Contractor. Tree Protection: Trees to be retained shall be protected during site works and construction by the erection of solid barricades to the specification of Council. Storage of machinery or materials beneath canopy of trees to be retained shall not be permitted. Changes to soil beneath canopy of trees to be retained shall not be permitted unless under direct supervision of Landscape Architect. Existing trees shall be pruned to Landscape Architects onsite

Soil Preparation: Cultivate to depth of 300mm all proposed lawn & garden areas incorporating minimum 100mm depth of organic clay breaker into existing site soil. Do not cultivate beneath existing trees to be retained. In areas where fill is required shapes & levels using a premium grade topsoil mix to garden areas where excavation is required shapes & levels using a premium grade topsoil mix to lawn areas. Undertake all required action to ensure that no rootballs of proposed plants sit in clay wells and the end result of the project is that all lawn and garden areas drain sufficiently (both surface & subsurface), are at required finished levels and have sufficient soil depths to enable lawn and plants to thrive and grow. Should alternative works to those specified be required to achieve the above result, Contractor shall inform Builder at time of Tender and request instructions. Lawn Edging and Stepping Stones: (i) 125 x 25mm approved tanalith impregnated pine edging shall be installed, to lines as indicated on plan and stakes shall be installed to edging with approved bricks on edge on a minimum 100mm deep x 90mm wide concrete footing with brick tor set in, to lines nominated on plan as brick edging shall be positioned as indicated on plan on a 25mm river sand bed. Approved sandstone stepping stones shall be positioned as indicated on plan on a 25mm river sand bed.

Retaining Walls: Positions, detail and heights of retaining walls shall be by others. Planting: Purchase plants from an approved nursery. Plants to be healthy & true to type & species. Set out plants to positions indicated on plan. Followed by 100mm deeper than plant rootballs that they are to receive. Base and sides of hole shall be further loosened. Fertiliser, followed by 100mm deeper than plants to positions indicated on plan. Following approval, plant then be placed into base of hole and lightly consolidated. Base of hole shall then be watered. Remove plant container and install plant into hole. Rootball shall be backfilled with surrounding topsoil and topsoil firmed into place. An approved shallow dish shall be thoroughly watered and maintained for the duration of the Contract. Staking: All trees shall be staked using 2 x 38mm x 38mm x 2000mm long hardwood stakes per plant and with hessian webbing ties installed to Landscape Architect's on site instructions.

Mulching: Install 75mm depth of 25mm diameter hardwood mulch to all garden areas, coving mulch down around all plant stems & to finish flush with adjacent surfaces. Turfing: Prepare for, level & lay cultivated Palmetto Buffulo turves to all areas nominated on plan as being lawn. Roll, water, fertilise, mow & maintain lawn's as necessary until completion of maintenance period. At same time make good all existing lawn areas using same lawn type. Lawns in shade shall be over sown with an approved seed mix. Allow to retrim and returf councils nature strip as required.

Fencina: Retain all existing fences unless advised otherwise by builder. Install timber paling fences to heights indicated on Plan.

Paving: Areas to be paved shall be excavated or filled to allow for installation of bedding materials. Levels and falls shall be as per Plan. Surface drainage on paving shall be towards grated drains with all drains connected to stormwater system and installed by Builder. Irrigation: Contractor shall supply and install an approved fully automatic, vandal resistant, computerised irrigation system to all garden and lawn areas, excluding council nature strip. Entire system shall be to approval of Water Board Completion: Prior to practical completion remove from site all unwanted debris occurring from work. Satisfy Council that all landscaping work has been undertaken in strict accordance with Councils landscape codes & guidelines.

Maintenance Period: A twelve month maintenance of all work specified under this Contract and shall be undertaken by owner or owners representative as set out herein. Owner shall be herein known as the Maintenance Period of 52 weeks following Practical Completion of Landscape Works. This period shall be herein known as the Maintenance Period. Work shall also include for the care and maintenance of all existing vegetation to be retained and proposed vegetation. Site shall be attended at least weekly and as otherwise required. The following works shall be undertaken during the Maintenance Period. (a) Recurrent works Undertake recurrent works throughout the Maintenance Period. These works shall include but are not limited to watering, weeding, fertilising, pest and disease control, returfing, staking and tying, replanting, cultivation, pruning, aerating, renovating, top dressing and the like.

(b) Watering Regularly water all plants and lawn areas to maintain optimal growing conditions. Contractor shall adjust the water quantity utilised with regard to climatic conditions prevalent at the time.

(c) Replacements Immediately replace plants which die or fail to thrive (at discretion of Landscape Architect) with plants of same species or variety and of same size and quality unless otherwise specified. Plant replacement of plants due to vandalism or theft shall be undertaken by Contractor and shall be paid for by

Client at an agreed predetermined rate. d) Mulched surface's Maintain mulched surfaces in clean, tidy, weed-free condition and shall reinstate mulch as necessary to maintain specified depths.

Stakes & ties Adjust and/or replace stakes and ties as required. Remove stakes and ties at end of Maintenance Period if directed by Landscape Architect. (f) Lawn areas Lawn areas shall be mown at regular intervals to ensure non heading of lawn by others shall be determined on site taking into consideration season, watering and growth rate of lawn by others shall be regularly mown as required to ensure a healthy lawn and a neat appearance. Care shall be taken to ensure that no clippings are left on surrounding roads or garden areas after mowing. Replace lawn areas that fail to thrive at discretion of Landscape Architect. All new and made good lawn areas that fail to thrive at discretion of Landscape Architect. All new and made good lawn areas that fail to thrive at discretion of Landscape Architect. All new and made good lawn areas that fail to thrive at discretion of Landscape Architect. All new and made good lawn areas that fail to thrive at discretion of Landscape Architect. (g) Weeding Remove by hand, or by carefully supervised use of weedicide, any weed growth that may occur throughout Maintenance Period. This work shall be executed at weekly intervals so that all lawn and garden areas may be observed in a weed-free condition.

n) Pruning Prune new and existing plants (excluding existing trees) as necessary to maintain dense foliage conditions. Any rogue branches overhanging or obstructing pathways, roads, doorways, etc., shall be removed by approved horticultural methods. i) Spraying Spraying for insect, fungal and disease attack shall be undertaken as required and in accordance with spray manufacturers recommendations at intervals taking into account the season of year during which landscape works are to be implemented. (j) Tree Care Should any existing trees be damaged during construction works immediately engage an experienced arboriculturist and then undertake any rectification work recommended by arboriculturist.

Legend	Project	Notes	Revision	<u>Description</u>	<u>Date</u>	DRAWING COVER SHEET
	TOWNHOUSE	All dimensions and levels shall be verified by Contractor on site prior to commencement of work.	A B	PRELIMINARY ARCHITECTURAL & STORMWATER UPDATE	07/03/19 21/03/19	ADDRESS 12-16 FRANCIS STREET, MINTO.
	DEVELOPMENT	2. Do not scale from drawings.3. If in doubt contact Landscape Architect.	С	COUNCIL'S REQUEST FURTHER INFORMATION	27/09/19	A Total Concept Landscape Architects & Swimming Pool Designers L/00 L/00
	<u>Architect</u>	4. This design is copyright and shall not be copied, utilised or reproduced in any way without prior written permission of A Total Concept Landscape Architects.				65 West Street, North Sydney NSW 2060 Tel: (02) 9957 5122 Fx: (02) 9957 5922 CHKD SW
	URBAN 🗗 LINK PTY LTD	5. This plan has been prepared for D.A purposes only.6. All Building Works shall be installed to Structural Engineers				PROJECT #



ST150/U/SC

INVERT LEVEL 🥫

37.78 38.16



SAFETOUCH 150

In-Ground & Recessed, Architectural & Commercial CAT. NO ST150

The SafeTouch150 inground uplighter has been specifically designed with public safety as its primary objective. It produces high-output optically pure light, but operates with cool lens temperatures, low energy consumption and minimal maintenance. It has a fully adjustable gimbal allowing 360 rotation and 0-20 elevation. This luminaire is extremely tough, durable and waterproof, making it ideal for installation in public spaces, large-scale projects and residential areas.

A Direct Burial option is available without the mounting canister, for installation directly in the soil or where there is limited depth.

Pure LED			
LED Chip	Cree CXA 2540 Plug and Play, field replaceable LED		
Output	5000 Lumens at 1400mA		
Lumens Per Watt	90 Lumens @ 56 total system watts		
Colour Temperature	2700K, 3000K, 4000K		
CRI Warm White (3000K)	80 standard, 90+ optional		
Beam Angles	22, 33, 51 Degrees		



250 10"

TWIN BAR LITE

Ground & Deck Mount CAT. NO TBL

The Twin Bar Lite is ideal for wall or sign illumination. The luminaire has two individual spot lights which can be aimed in two entirely different directions. Each head has a fully adjustable arm allowing 360 degree rotation and 0 - 90 degree elevation adjustment.

Pure LED	
LED Chip	Cree XHP-50-2 Plug and Play field replaceable LED boards
Output	600 Lumens @ 1050mA
Lumens Per Watt	100 Lumens @ 6 watts
Colour Temperature	2700K, 3000K, 4000K
CRI Warm White (3000K)	90 standard
Beam Angles	15, 25, 38, 60 degrees



Includes a matching aluminium backing plate

90° Tilt / 270° Swivel

 High output reflector to maximise light 240v GU10 2x35w max/12v MR16 2x20w max





Matt Black Wall Pillar Fixed Spot Lights


- Fixed wall pillar light
- Aluminium poly powder coated black
- Includes a matching aluminium backing plate
- High output reflector to maximise light 240v GU10 35w max/12v MR16 20w max




ALL LIGHTING TO BE INSTALLED TO MANUFACTURER'S SPECIFICATION, INCLUDING ANY REQUIRED LED DRIVERS, TRANSFORMERS, SWITCHING, WIRING & THE LIKE.

GROUND FLOOR LIGHTING PLAN **SCALE 1:100**

LANDSCAPE LIGHTING SCHEDULE

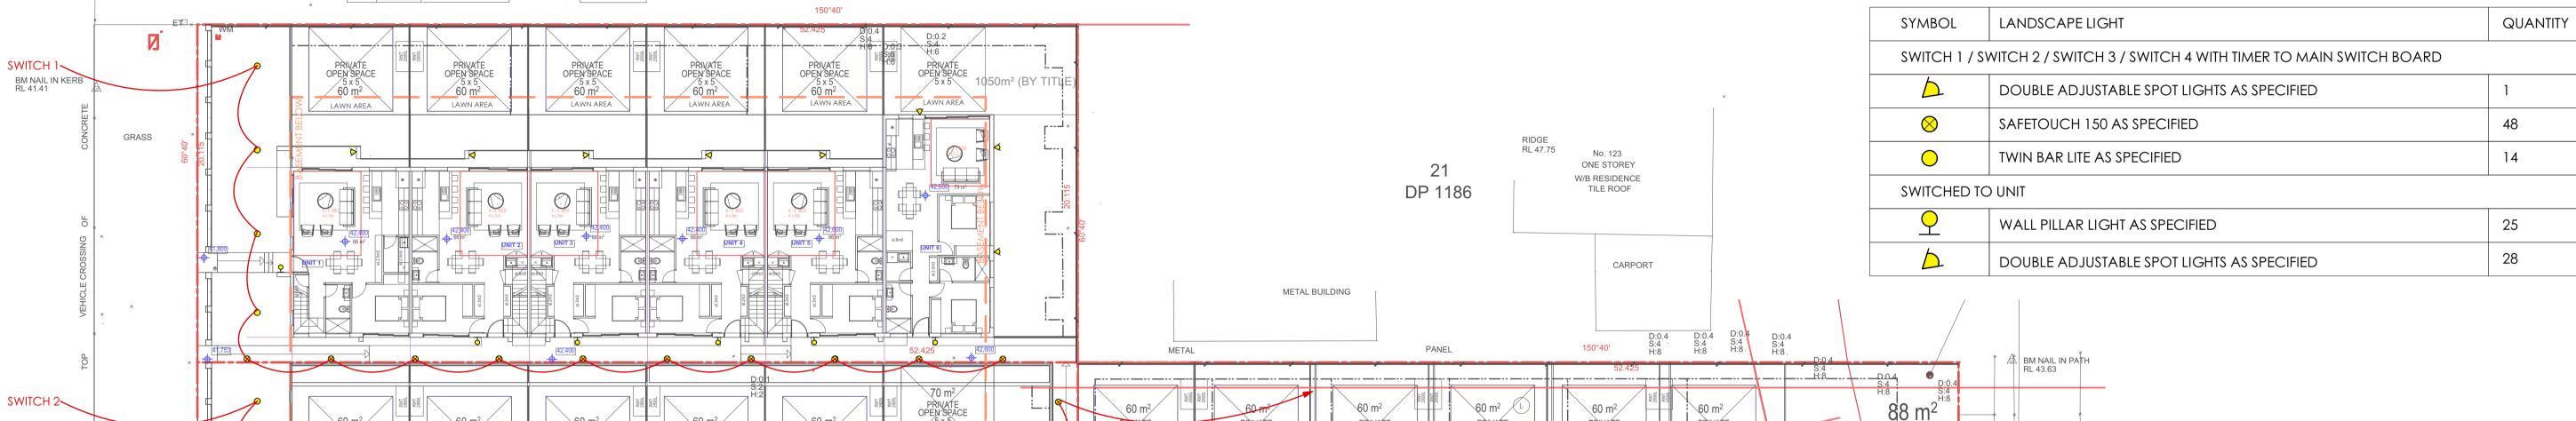

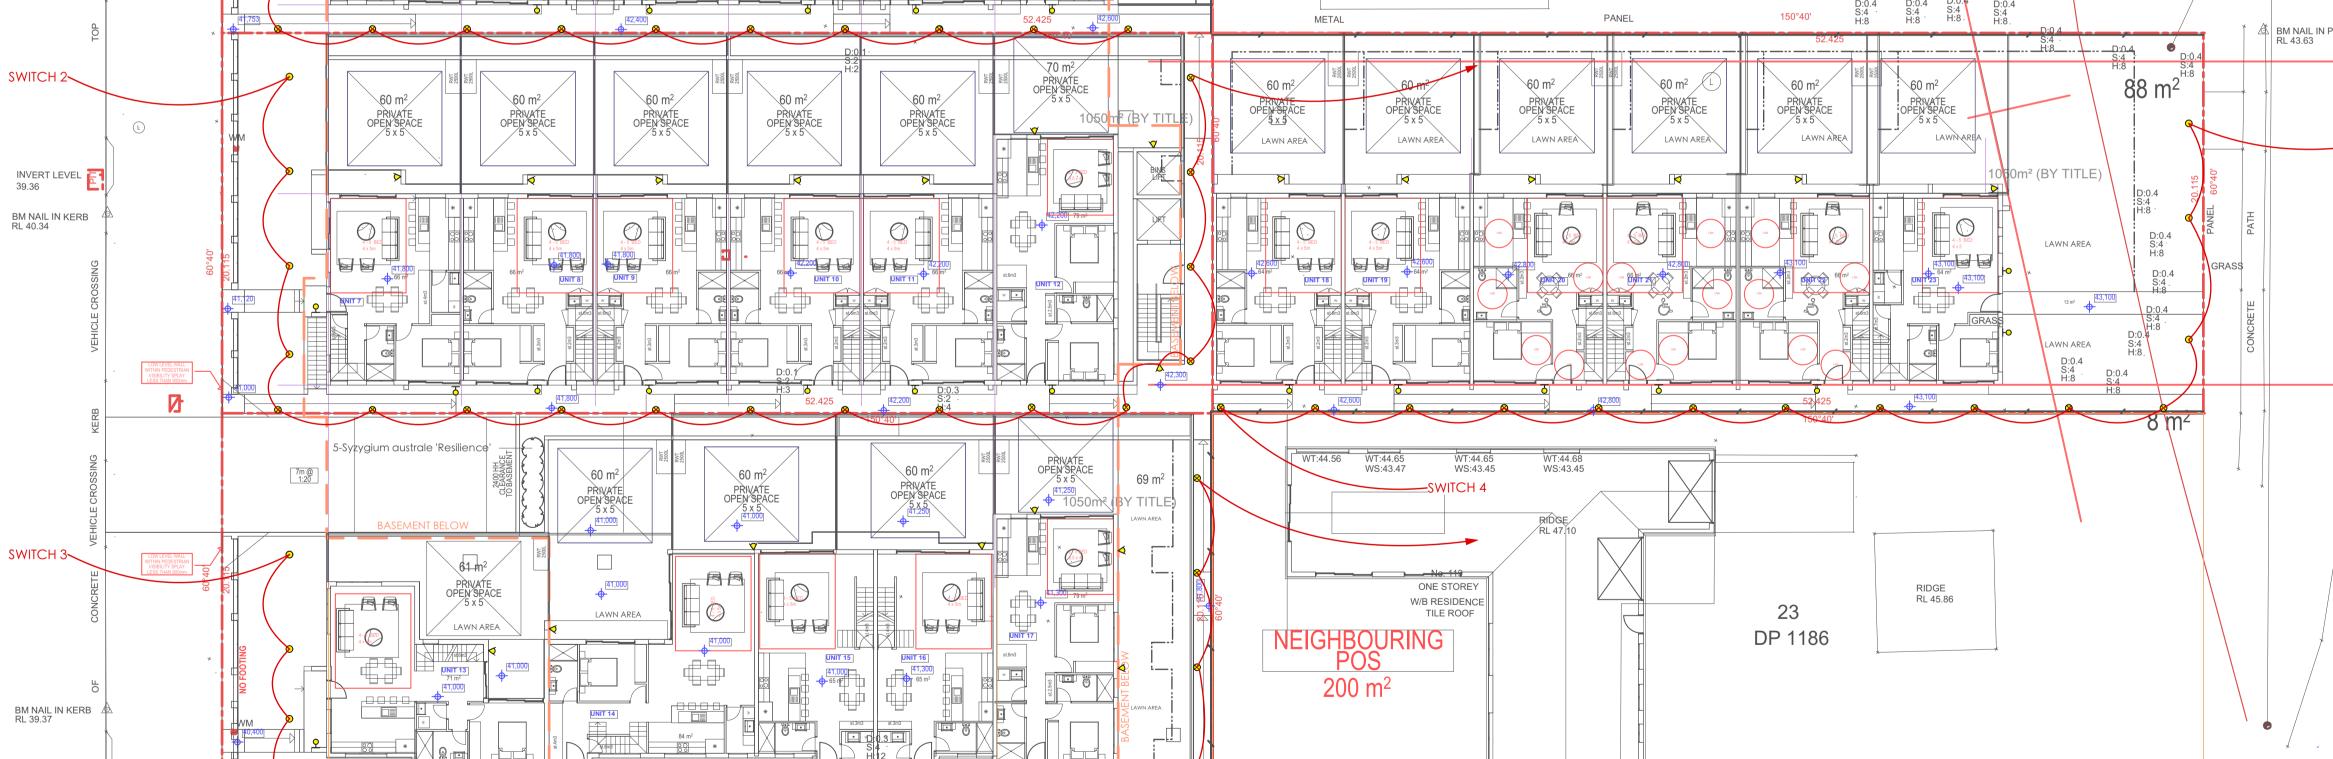

<u>Legena</u>		 BASEMENT BELOW		BOUNDARY LINE		FUTURE ROAD WIDENING	Project
PROP	POSED PAVED AREA	EXISTING TREE TO BE REMOVED	•	EXISTING TREE TO E	BE RETAINED		TOWNHOUSE DEVELOPMENT
PROP	POSED MASONRY RETAINING WALL	 TIMBER LAWN EDGE		PROPOSED 1.2m H HOB WALL & HORI	IGH MASONRY PIERS ZONTAL SLATS FROM	S WITH LOW NT FENCE	
LAWN	N AREA	PROPOSED 1.8m HIGH DECORATIVE	E PRIVACY FEN	NCE			<u>Architect</u>
PROPO	POSED CONCRETE DRIVEWAY	 EXISTING1800mm HIGH BOUNDARY	/ FENCE	PRC	POSED CLOTHESLIN	E	URBAN LINK PTY LTD

Notes

1. All dimensions and levels shall be verified by Contractor on site prior to commencement of work.

- 2. Do not scale from drawings.
- 3. If in doubt contact Landscape Architect.
- 4. This design is copyright and shall not be copied, utilised or reproduced in any way without prior written permission of A Total Concept Landscape Architects.
- 5. This plan has been prepared for D.A purposes only. 6. All Building Works shall be installed to Structural Engineers

Revision	<u>Description</u>	<u>Date</u>	DRAWIN PRO
А	PRELIMINARY	07/03/19	ADDRES
В	ARCHITECTURAL & STORMWATER UPDATE	21/03/19	12-1
С	COUNCIL'S REQUEST FURTHER INFORMATION	27/09/19	А То
			& Sw 65 West
			Tel: (02)
			a to

PROPOSED LIGHTING PLAN			
12-16 FRANCIS STREET, MINTO.			DWG #
A Total Concept Landscape Architects	DATE #	07/03/19	L/02
& Swimming Pool Designers	SCALE @ A1	1:200	
65 West Street, North Sydney NSW 2060 Tel: (02) 9957 5122 Fx: (02) 9957 5922	DRAWN	JC	
	CHKD	SW	1// S. \
atc	PROJECT #		
a total concept			